DEVELOPMENT PROPOSAL FOR PUBLIC COMMENT

The following development proposal has been submitted to the Council and although not designated under the Environmental Planning & Assessment Act, 1979, is notified for public comment:

Portal Application Number	DA No.	Location	Proposal
PAN-524334	84/2025	LOT: 15 SEC: 2 DP: 758366, 24 Dowling Street DUNGOG Applicant: CAD Design & Draft Owners: Mr G L & Mrs N A Turner Consent Authority: Dungog Shire Council	Alterations & Additions to Existing Dwelling to provide Disabled Access in a Heritage Conservation Area

Details of the above proposal are available for inspection on the NSW Planning Portal website from **Thursday 8 May 2025.**

https://www.dungog.nsw.gov.au/Council/Council-Advertisements/Development-Applications

Submissions can be made via the NSW Planning Portal until **Thursday 22 May 2025**. If you require assistance making a submission via the Planning Portal, please contact Council.

In accordance with *Section 10.4* of the *Environmental Planning & Assessment Act 1979*, a person who makes a public submission to Council in relation to this application is required to disclose all reportable political donations within two years prior to the submission being made and ending when the application is determined.

If the submission includes an objection to the proposal, the grounds of objection must be given. Council may also be obliged to release your submission as required by the *Government Information (Public Access) Act 2009* and the *Environmental Planning and Assessment Act 1979.*

Further, as stipulated in Council's Public Submissions Policy C1.19, Council will not place any weight on anonymous submissions when determining the respective development application.

DUNGOG SHIRE COUNCIL EXHIBITED COPY

Commencement Date 8 May 2025

Closing Date

22 May 2025



DUNGOG SHIRE COUNCIL

Dungog Shire Council 198 Dowling Street PO Box 95 DUNGOG NSW 2420 Telephone: (02) 4995 7777 Facsimile: (02) 4995 7750 Email: <u>shirecouncil@dungog.nsw.gov.au</u> Website: <u>www.dungog.nsw.gov.au</u>

STATEMENT OF ENVIRONMENTAL EFFECTS



New Homes & Home additions

To assist Council in fully assessing your development application in accordance with legislative requirements it is necessary for you to provide comments or advice for the following questions. These relate to common matters which need to be addressed to mitigate potential impacts resulting from your proposed development.

1. Does the proposal comply with Council Building Line Setback?

SETBACK REQUIEMENTS

(Dungog Council's Shire Wide Development Control Plan No 1 (DCP) Part C 3)

Zone		perty Boundary Setback	Side & Rear Setback	Side & Rear Setback		
	Main Road Unclassified Road			Second road frontage corner block		
R5 - Large Lot Residential & E4 - Environmental Living	70m	30m	10m	10m		
NOTE - 15m from new roads within a R5 Large Lot Residential zoned subdivisions.						
RU1 - Primary Production	140m	50m	50m (lots >60ha) 40m (lots 30 – 60ha) 30m (Lots <30ha)	50m (lots >60ha) 40m (lots 30 – 60ha) 30m (Lots <30ha)		
R1 General Residential & RU5 - Village			· · · · · · · · · · · · · · · · · · ·			
Single Storey Double Storey	6m 7.6m		900mm 1500mm	3m		

NOTE - Additional requirements apply for Count Street& Boulton Drive, Paterson see Dungog Council DCP Part D. May also apply for specific new subdivisions, see Council for further information if required.

Proposed setbacks:

a)	Proposed setback <u>14</u> metres. Front Property Boundary Setback complies?
	Yes \checkmark No O Existing setback <u>14</u> m if applicable.
ь)	Proposed setback <u>4.84</u> metres. Side & Rear Setback complies?
	Yes \checkmark No O Existing setback <u>4.84</u> m if applicable.
c)	Proposed setback 4.02 metres. Side & Rear Setback complies?
	Yes \checkmark No \circ Existing setback <u>4.02</u> m if applicable.
d)	Proposed setback <u>72</u> metres. Side & Rear Setback (if applicable) complies? (Secondary road frontage only)
	Yes \checkmark No O Existing setback <u>72</u> m if applicable.

2. Will the development require disposal of effluent waste water (eg bathrooms, ensuite, kitchens, laundry, toilets etc)?

Yes O No 🔗

3. If so where will the waste water be disposed of to

Effluent waste water to:

i) Hunter water corporation sewer	Yes	0	No	0
ii) Onsite disposal to existing system	Yes	0	No	0
iii) New onsite disposal system	Yes	0	No	0

Note – Onsite effluent waste water disposal from new houses or house additions will require a separate application. See council Environmental Health Department for further information.

4. Is a BASIX certificate required?

Yes No O

When is a BASIX certificate required -

- **1 July 2011** for **BASIX Certificates issued for all new dwellings** (new single houses, townhouses, apartments, residential flat buildings and secondary dwellings).
- **30 September 2011 for BASIX Certificates issued for Alterations and Additions** (of construction value \$50,000 or more, and for pools of 40,000 litres or more).

5. Does the development require any demolition of existing structures?

Yes 🗹 No O

If yes please provide details on the proposed waste management including asbestos and other waste materials.

Waste management will be in accordance with the Site Waste Minimisation & Management Plan on drawing 24-048-A03

6. Is your proposed building consistent with the type of similar development in the immediate area including external finishes, size, height etc?

If not what measures are proposed to reduce the impact? (eg Landscaping, screening, painting).

Colours for walls are – The proposed cladding material and colour will match the existing building. The existing weatherboard cladding is a pale yellow which will remain.

Colours for the roof are - The roof sheeting will match the existing building. The existing roof sheeting is a light colour which will be match on the new development.

7. Is the land subject to bushfire threat?

Note - See Council bushfire prone mapping on council's website or visit our offices. Consideration also needs to be given to unmanaged grasslands which are not mapped on Councils bushfire threat mapping.

Yes O No Ø

If yes, a bush fire threat assessment will be required for the proposed development. See www.rfs.nsw.gov.au for further information on bushfire protection requirements or contact a bushfire threat consultant.

8. Is the land subject to natural or other hazards such as flooding, drainage, land slip, acid sulphate soils, slope, and similar risks? If yes, to what extent? What measures will be taken to overcome these matters?

Yes O No 🔗

9. Will the development require the removal of any trees/shrubs? If yes, specify approximate areas, tree sizes and numbers.

Note: This can be illustrated on a site plan.

Yes O No 🔗

10. Does the development involve excavation works which may cause soil erosion?

Yes O No 🔗

If yes, what steps are to be taken to reduce soil erosion potential? (eg Sediment traps, vegetating bare earth).

 Where will the stormwater from the roof be disposed to?	
	_
	_

To the street		Yes	Ø	No	0
To a water store	age tank overflow to:				
a)	Street	Yes	0	No	0
b)	absorption trench	Yes	0	No	0
c)	drainage easement	Yes	0	No	0
d)	existing drainage channel	Yes	0	No	0
To an inter allot	ment drainage system	Yes	0	No	0
To the existing :	stormwater drainage system	Yes	0	No	0
To an onsite rub	ble pit or absorption trench	Yes	0	No	0

Other (provide details): New downpipes will be connected into existing system and drainage to street.

12. Will the development be located over or adjacent to Hunter Water Corporation sewerage mains? (Note: All applications in sewered areas must be stamped by the Hunter Water Corporation prior to lodging your application)

Yes O No O Near sewer but not required

If yes what measures have been taken to ensure that no structural loads will be imposed on the mains? $N\!/\!A$

13. Does your development require construction of a new driveway crossing?

Yes O No 🔗

14. Is the proposed development located in a heritage conservation area or is there a heritage item situated on the property?

Yes 🔗 No O

If yes please see Dungog Shire Council DCP 17 on our website for further information.

The proposed additions are very minor additions to the rear of the existing dwelling. The proposed development is entirely obscured from street level and is generally within the existing footprint

of the existing building. The proposed addition will have no impact on the heritage significance of the area

15. Other Matters.

The proposed development is designed to improve access for the disabled occupant of the dwelling and provide adequate maneuvering area for disabled access. The minor addition is in keeping with the existing building design and is a very small extension of the existing rear skillion profile.


Vehicle access will remain as per the existing conditions and are not affected by the development.

Stormwater from the proposed addition will be connected into the existing stormwater system and drained to Dowling Street.

Applicants Signature:

Date: 20-3-25

Applicant's Name (Please Print): Peter Barnes - CAD Design & Draft

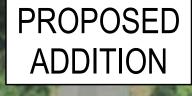



Clear of Hunter Water Assets

Reference No: 151753

 ✓ Water available for connection
 ✓ Sewer available for connection
 53 Date Processed: 01 April 2025 Applicant: CAD Design & Draft Pty Ltd -Peter Barnes Property Location: LOT 15 SECTION 2 DP 758366 24 DOWLING ST DUNGOG NSW 2420

PLEASE TAKE INTO CONSIDERATION

This is not a compliance certificate. This stamp indicates that Hunter Water has undertaken an initial assessment of the proposed development to identify possible impacts to our infrastructure. Conditions of Hunter Water easements apply. For information on Hunter Water's processes please refer to our 'Land Development Manual' on our website or contact us on 1300 657 657. Version 3.3 (22 December 2021)

Development Site Plan





ocality Map

Rev Description A ISSUED FOR DA

Date 5-3-25

Project Alterations & Additions Client Mr & Mrs Turner Address 24 Dowling Street Suburb Postcode Dungog NSW 2420 Lot DP Sec 15 758366 2 Council Dungog Drawing Title Development Site Plan Date Scale at A3 Drawn PJB November 24 1:100 Project Status NOT FOR CONSTRUCTION Project No. Drawing No. Revision

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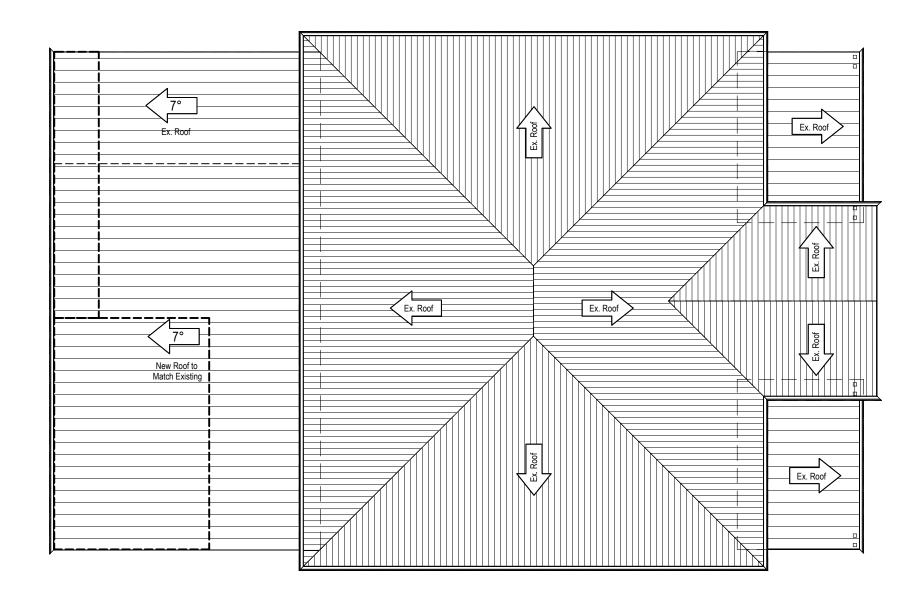
Alterations & Additions

24 Dowling Street Dungog NSW 2420





NCC NCC-HP 10.0 RL RL X	Refers to N Refers to A 	egend ational Construction Code 2022 BCB Housing Provisions section of NCC Boundary Line Fenceline Contour Line Spot Level Benchmark to Australian Height Datum (AHD) Rainwater Tank Location Tree Height / Spread / Diam	ABN: 336 mail@caddd.c ALWAYS use gi All sizes, dimensions an for All materials & wo Report all error Plans are considered 'PRE unless 'PRO'E	Contail WWW where the starts is the preference of a starts the starts and the preference of a starts the starts and the starts is the starts the starts and the starts is the starts the starts and the starts and the starts the starts and the starts and the starts the starts and the st	Y LTD 10 462884 v.caddd.com.au dmasaremnta en on sie by builder prior fwar. Balance and the second second second second second second effects and the second second second second second second second second second second second second second second
	Incoom Ies ← MV SA I oFW 2.5° Metal RC roof sheeting rocturers specifi	Bin Storage Location Door / Window Tag (Refer Schedule) Proposed Floor Level (Refer Survey for Datum) Indicates Room Use Indicates Room Use Indicates Floor Finish Provide mechanical ventilation to eave in accordance with NCC-HP 10.8.2 Provide smoke alarms to ceiling in accordance with NCC-HP 10.8.2 Provide smoke alarms to ceiling in accordance with NCC-HP 10.8.2 Indicates tiled wet areas in accordance with HAD1, HAU28 (HAJ3 of the NCC-HP 10.2. Provide falls to all wastes between 1:50-1:80 in accordance with NCC-HP 10.2.12 Indicates floor and shower wastes in accordance with NCC-HP 10.2.12 and NCC H4D3.Provide fall to wastes between 1:50-1:80 in accordance with NCC H4D1.2.12 Indicates Existing / Proposed Roof Pitch to be installed in accordance with cations, NCC-HP 7.2 and NCC H2D6	Acid Sulfare Solls	No Acid Su	fate Solis
	no Corrugated' pr 5 c 'Trimdek' prol 2 c 2 c 'Klip-Lok' prol 1	sheeting profile is to be suitable for minated roof pitch. legrees or greater. tile suitable for roof pitches of degrees or greater tile suitable for roof pitches of degree or greater. all Types Reinforced Blockwork Wall Single Skin Brick Wall Double Skin Brick Wall Brick Veneer Wall Cavity Brick Wall Concrete Wall			
Provide a	AJ CBD CK/O DP Dr DW Fr FW RWT SHR Si T V WM Termite F ppproved termi ith requirement Survey infor	Timber or Steel Framed Wall Walls to be demolished bbreviations Articulation Joint Cupboard Cooktop / Oven Downiple Location Clothes Dryer Dishwasher Fridge Floor Waste Rainwater Tank Shower Sink Tub Vanity Washing Machine Prevention Measures te barriers and ensure construction complies ts of AS 3660.1:2014 & NCC-HP 3.4 Temation has been taken from original survey provided by registered surveyor.	Suburi Dungog Lot 15 Drawn PJB NOT F	4 Dowling Stre b DP 758366 Council Dungog Drawing Title Cover Sheet Date November 24 Project Status FOR CONSTRU	Postcode 2420 Sec 2 Scale at A3 1:100







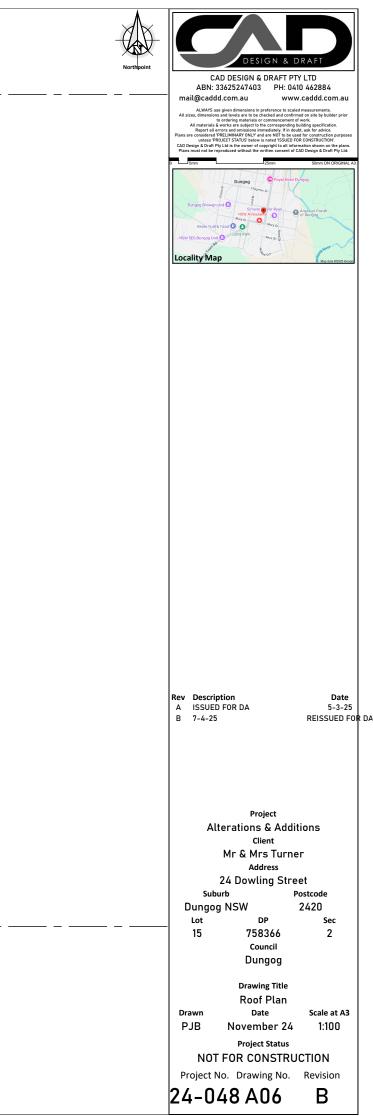


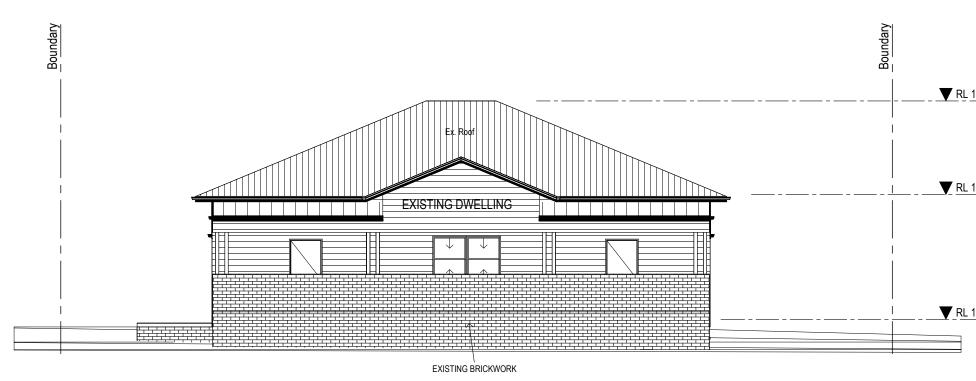


EXISTING FRONT ELEVATION REMAINS UNCHANGED - NEW WORK OBSCURED FROM STREET VIEW

Eastern Elevation

SCALE 1:100

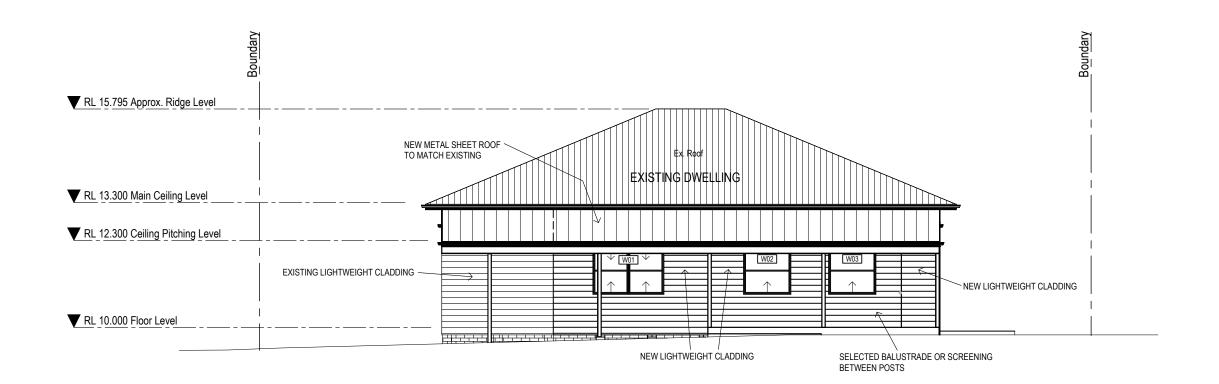

Western Elevation

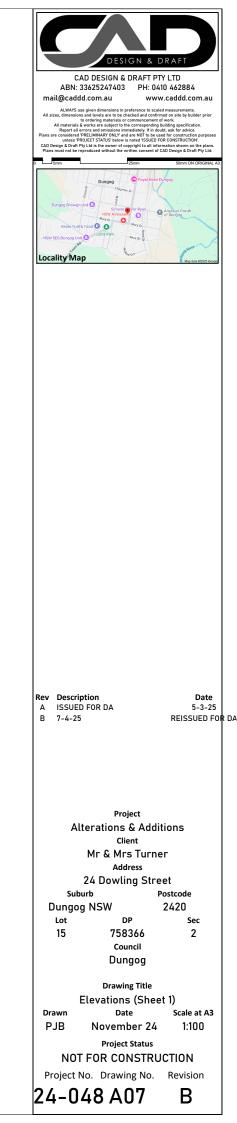

RL 15.795 Approx. Ridge Level

RL 13.300 Main Ceiling Level

RL 10.000 Floor Level

WINDOW SCHEDULE											
Refer to the BASIX certificate for specific requirements of all window frames and glass. BASIX certificate overides ANY discrepancies between this schedule and final BASIX certificate.											
	All sizes are nominal only and exact sizes are to be confirmed prior to ordering of any materials										
Window	Height	Width	Mate	erials	Head	Window Type	Area		Commonte		
Number	Height	width	Frame	Glazing	Height	window rype		a	Comments		
					GRC	OUND FLOOR					
W 01	1200	1800	Timber	Standard	2100	Double Hung	2.16	m2			
W 02	1200	1200	Timber	Standard	2100	Double Hung	1.44	m2			
W 03	1200	1200	Timber	Standard	2100	Double Hung	1.44	m2			
					DOOR						
	Re	fer to the BASIX ce	rtificate for specific requi	rements of all window fr	ames and glas	ss. BASIX certificate overide	s ANY disc	repancie	s between this schedule and final BASIX certificate.		
			All	sizes are nominal only ar	nd exact sizes	are to be confirmed prior to	o ordering	of any m	naterials		
Door	Height	Width	Mate	erials	Head	Door Type Area				Comments	
Number		Width	Frame	Glazing	Height				comments		
					GRC	OUND FLOOR					
D 01	2100	2100	Standard Aluminium	Please Select	2100	Sliding Door	4.41	m2			
Sliding Double Awning Casement Fixed Double Glass Louvres Hinged Sliding Door Hung											
Bu	Windows & Door Legend Builder to confirm ALL sizes on site before ordering Builder to confirm ALL sizes on site before ordering										

Housing Provisions & Australian Standards AS 1288, 2047 & 4055

SUMMARY OF BASIX COMMITMENTS This is a summary of BASIX commitments as detailed in the BASIX Certificate. Refer to the CURRENT BASIX Certificate for complete details. For definitions refer to www.basix.nsw.gov.au **BASIX Certificate No.** A1786172 Date WATER COMMITMENTS Fixtures 3 Star (> 7.5 but <= 9 L/min) Shower Heads Toilets **Kitchen Taps** Basin Taps 3 Star Lighting A minimum of 40% of new or altered light fixtures are to be fitted with fluorescent, compact fluorescent or LED lamps. SUMMARY OF THERMAL COMFORT COMMITMENTS IMPORTANT NOTE FOR DEVELOPMENT APPLICANTS The following specification details the requirements necessary to achieve the thermal performance values as required for compliance with BASIX. Once the development is approved by council, these specifications will become a condition of consent and MUST be included in the built works. If you do not want to include these requirements, or need further information, please contact CAD Design & Draft on 0410462884 **External Wall Construction** Insulation R1.30 Framed **Internal Wall Construction** Insulation Plasterboard on Studs None **Ceiling Construction** Insulation R1.76 Plasterboard **Roof Construction** Insulation Foil / Sarking Metal **Floor Construction** Insulation NIL Concrete Slab U Value Windows Glass Frame

Standard Aluminium

7.63

All (U.N.O)

Standard

